


PARKING DATA

EXISTING PARKING: 21 HANDICAPPED SPACES
 + 479 STANDARD SPACES
 = 500 TOTAL PARKING SPACES

ALT-1C PARKING: 20 HANDICAPPED SPACES
 + 469 STANDARD SPACES
 = 489 TOTAL PARKING SPACES
 + 23 OPTIONAL SPACES
 = 512 TOTAL PARKING SPACES

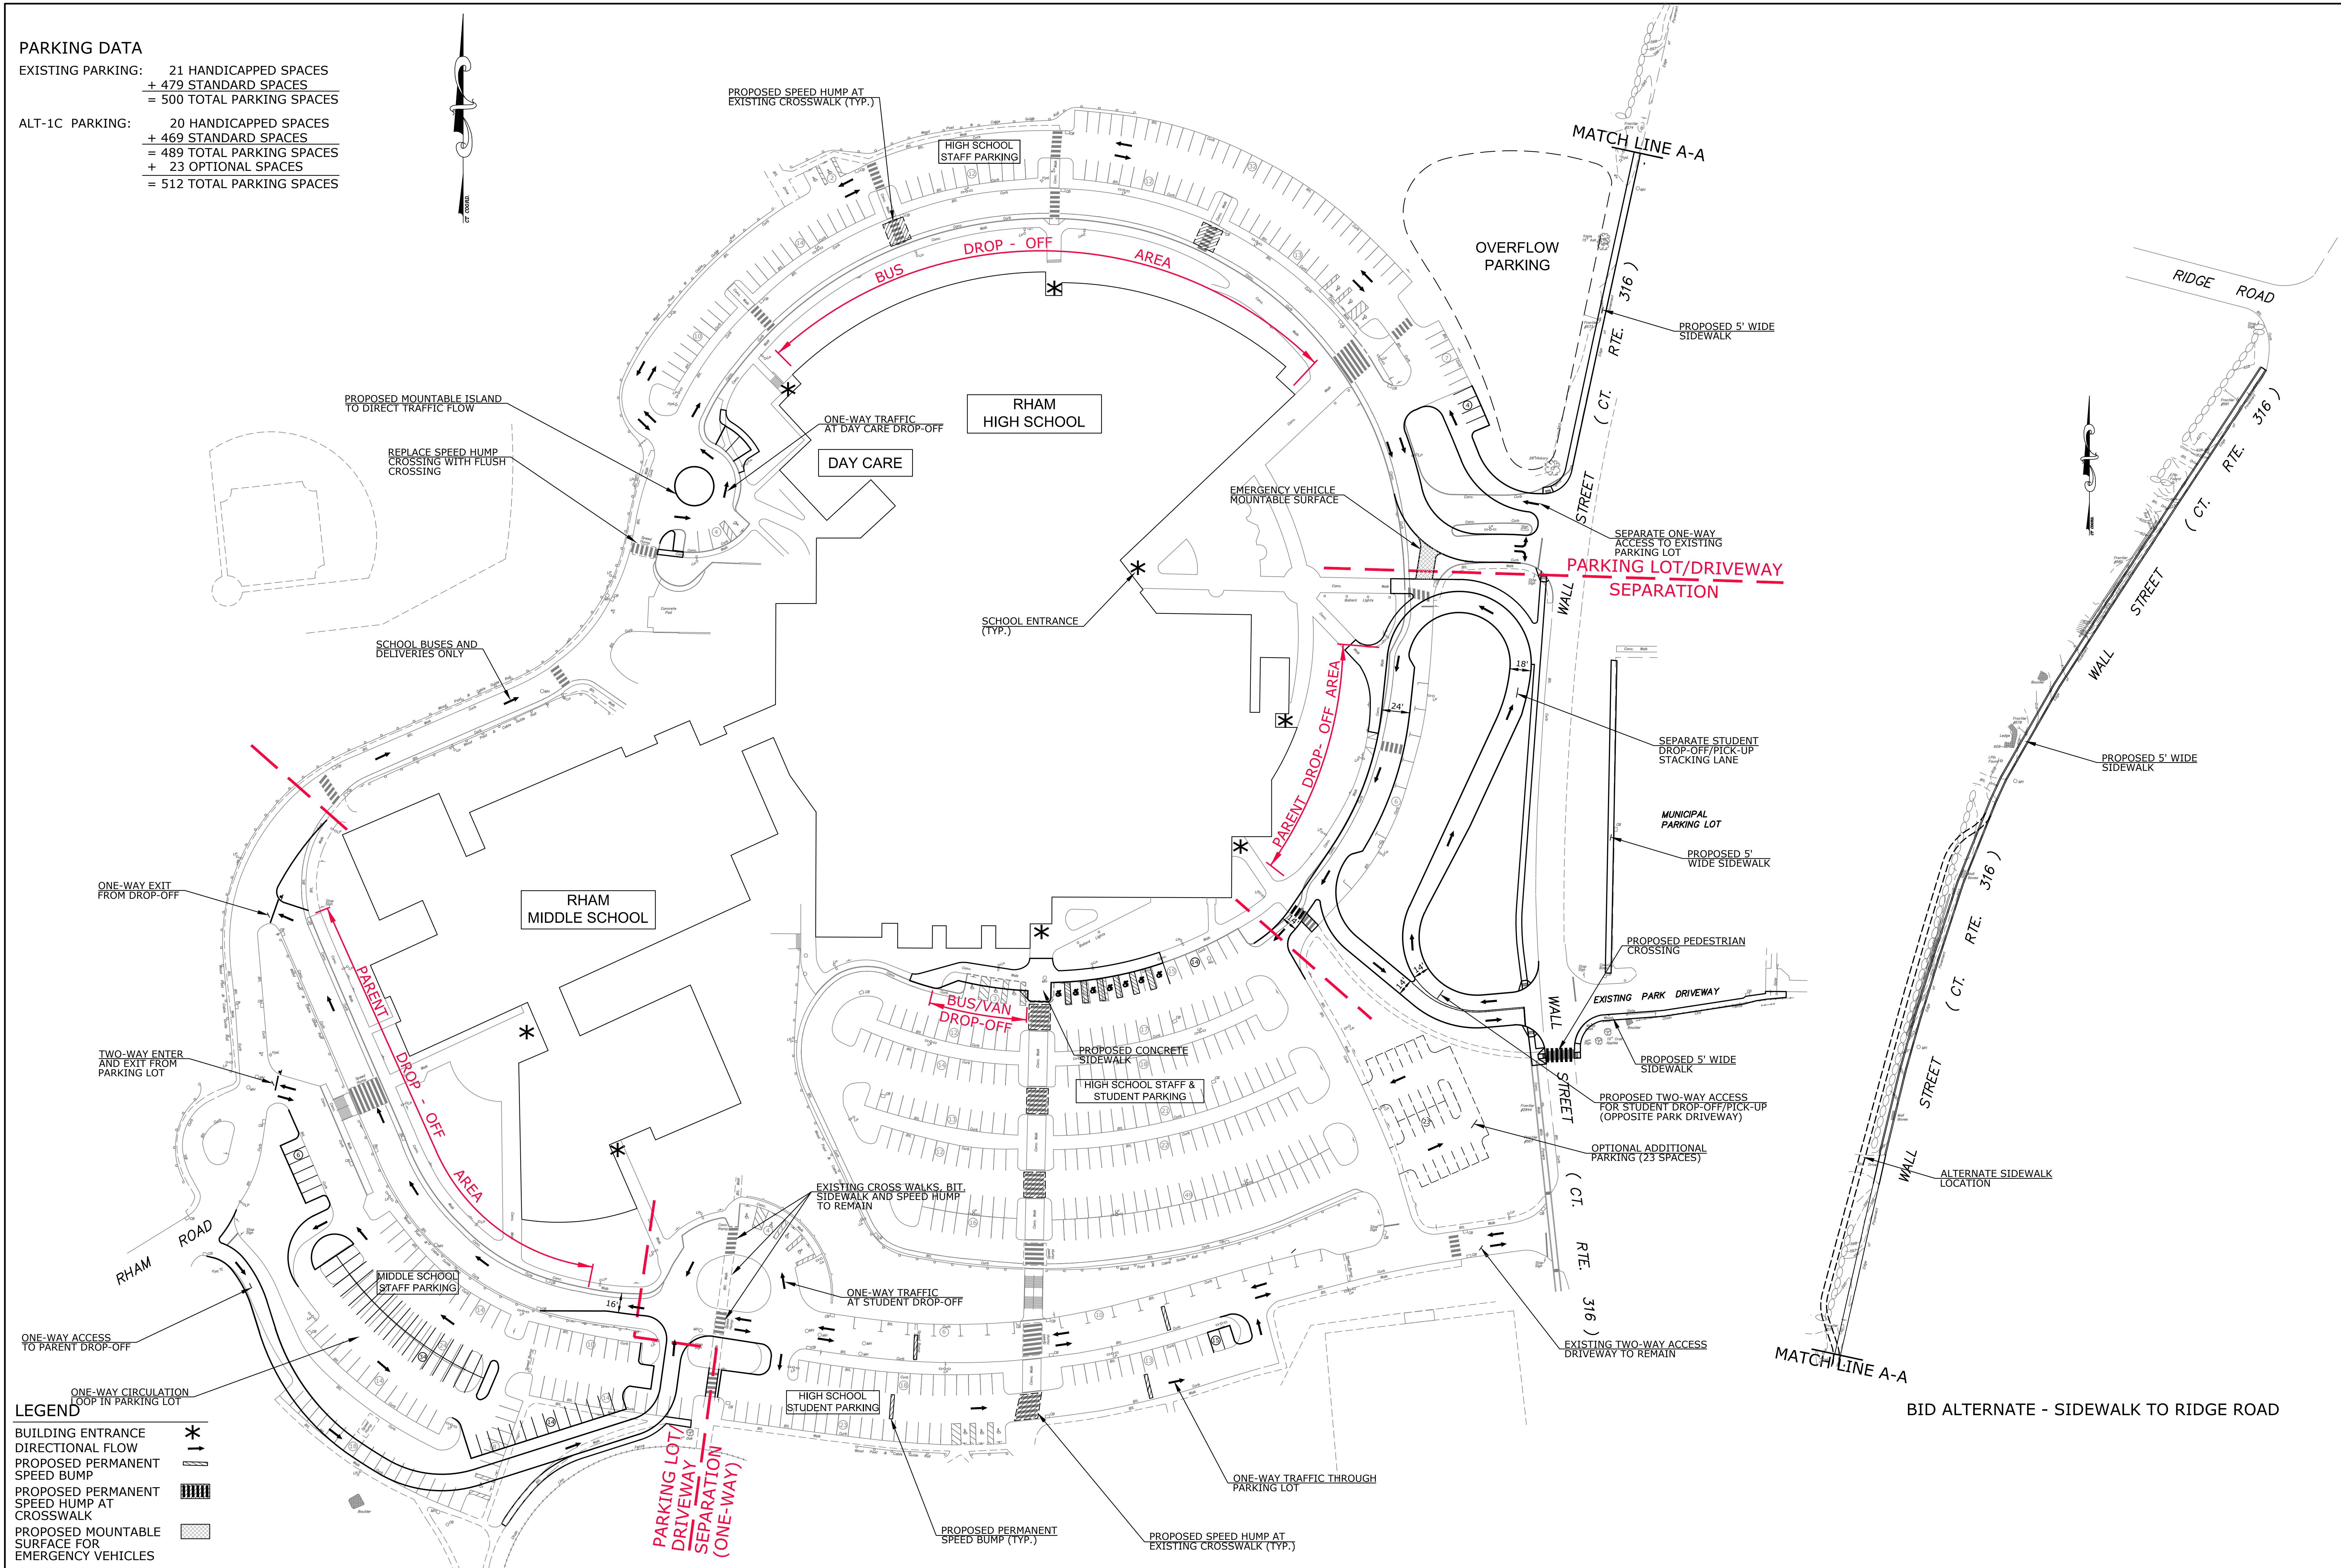

LEGEND

BUILDING ENTRANCE	*
DIRECTIONAL FLOW	→
PROPOSED PERMANENT SPEED BUMP	▬
PROPOSED PERMANENT SPEED HUMP AT CROSSWALK	▨
PROPOSED MOUNTABLE SURFACE FOR EMERGENCY VEHICLES	▩
ONE-WAY CIRCULATION LOOP IN PARKING LOT	→

Luchs
 CONSULTING ENGINEERS
 89 COLONY STREET • MERIDEN, CT
 TEL. 203-379-0320 • FAX. 203-379-0278

DESIGNER: DD
 DRAFTER: MLF
 CHECKED BY:
 SCALE: 1" = 50'

CONCEPTUAL SITE PLAN
 RHAM CAMPUS - PARKING LOT IMPROVEMENTS
 PARKING IMPROVEMENTS - ALTERNATE NO. 1C
 HEBRON, CONNECTICUT

PROJECT NO.: 17030
 DRAWING NO.: --
 SHEET NO.: ALT-1C

REV.	DATE	REVISION DESCRIPTION	SHEET NO.

FILENAME: Q:\Projects\Luchs\Projects\17030 Hebron RHAM campus\Design\Plans\XRef_RHAM_Proposed alt 1C.dwg 8/22/2018